





ALL GRAVEL PATHS AND DRIVEWAY TO USE A MIX OF 75% RIVER ROCK GRAVEL AND 25% BLUE STONE



CALIFORNIA POPPY (ESCHSCHOLZIA)


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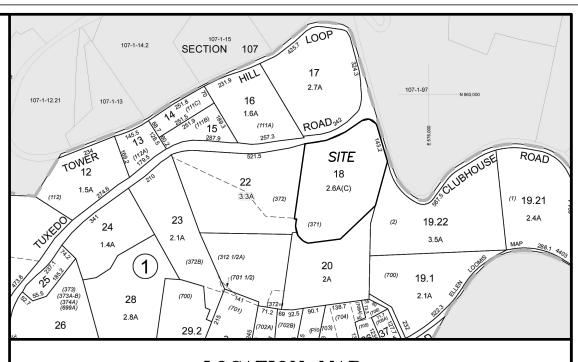
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(IN FEET)

1 inch = 30 ft.



LOCATION MAP N.T.S.

REFERENCE

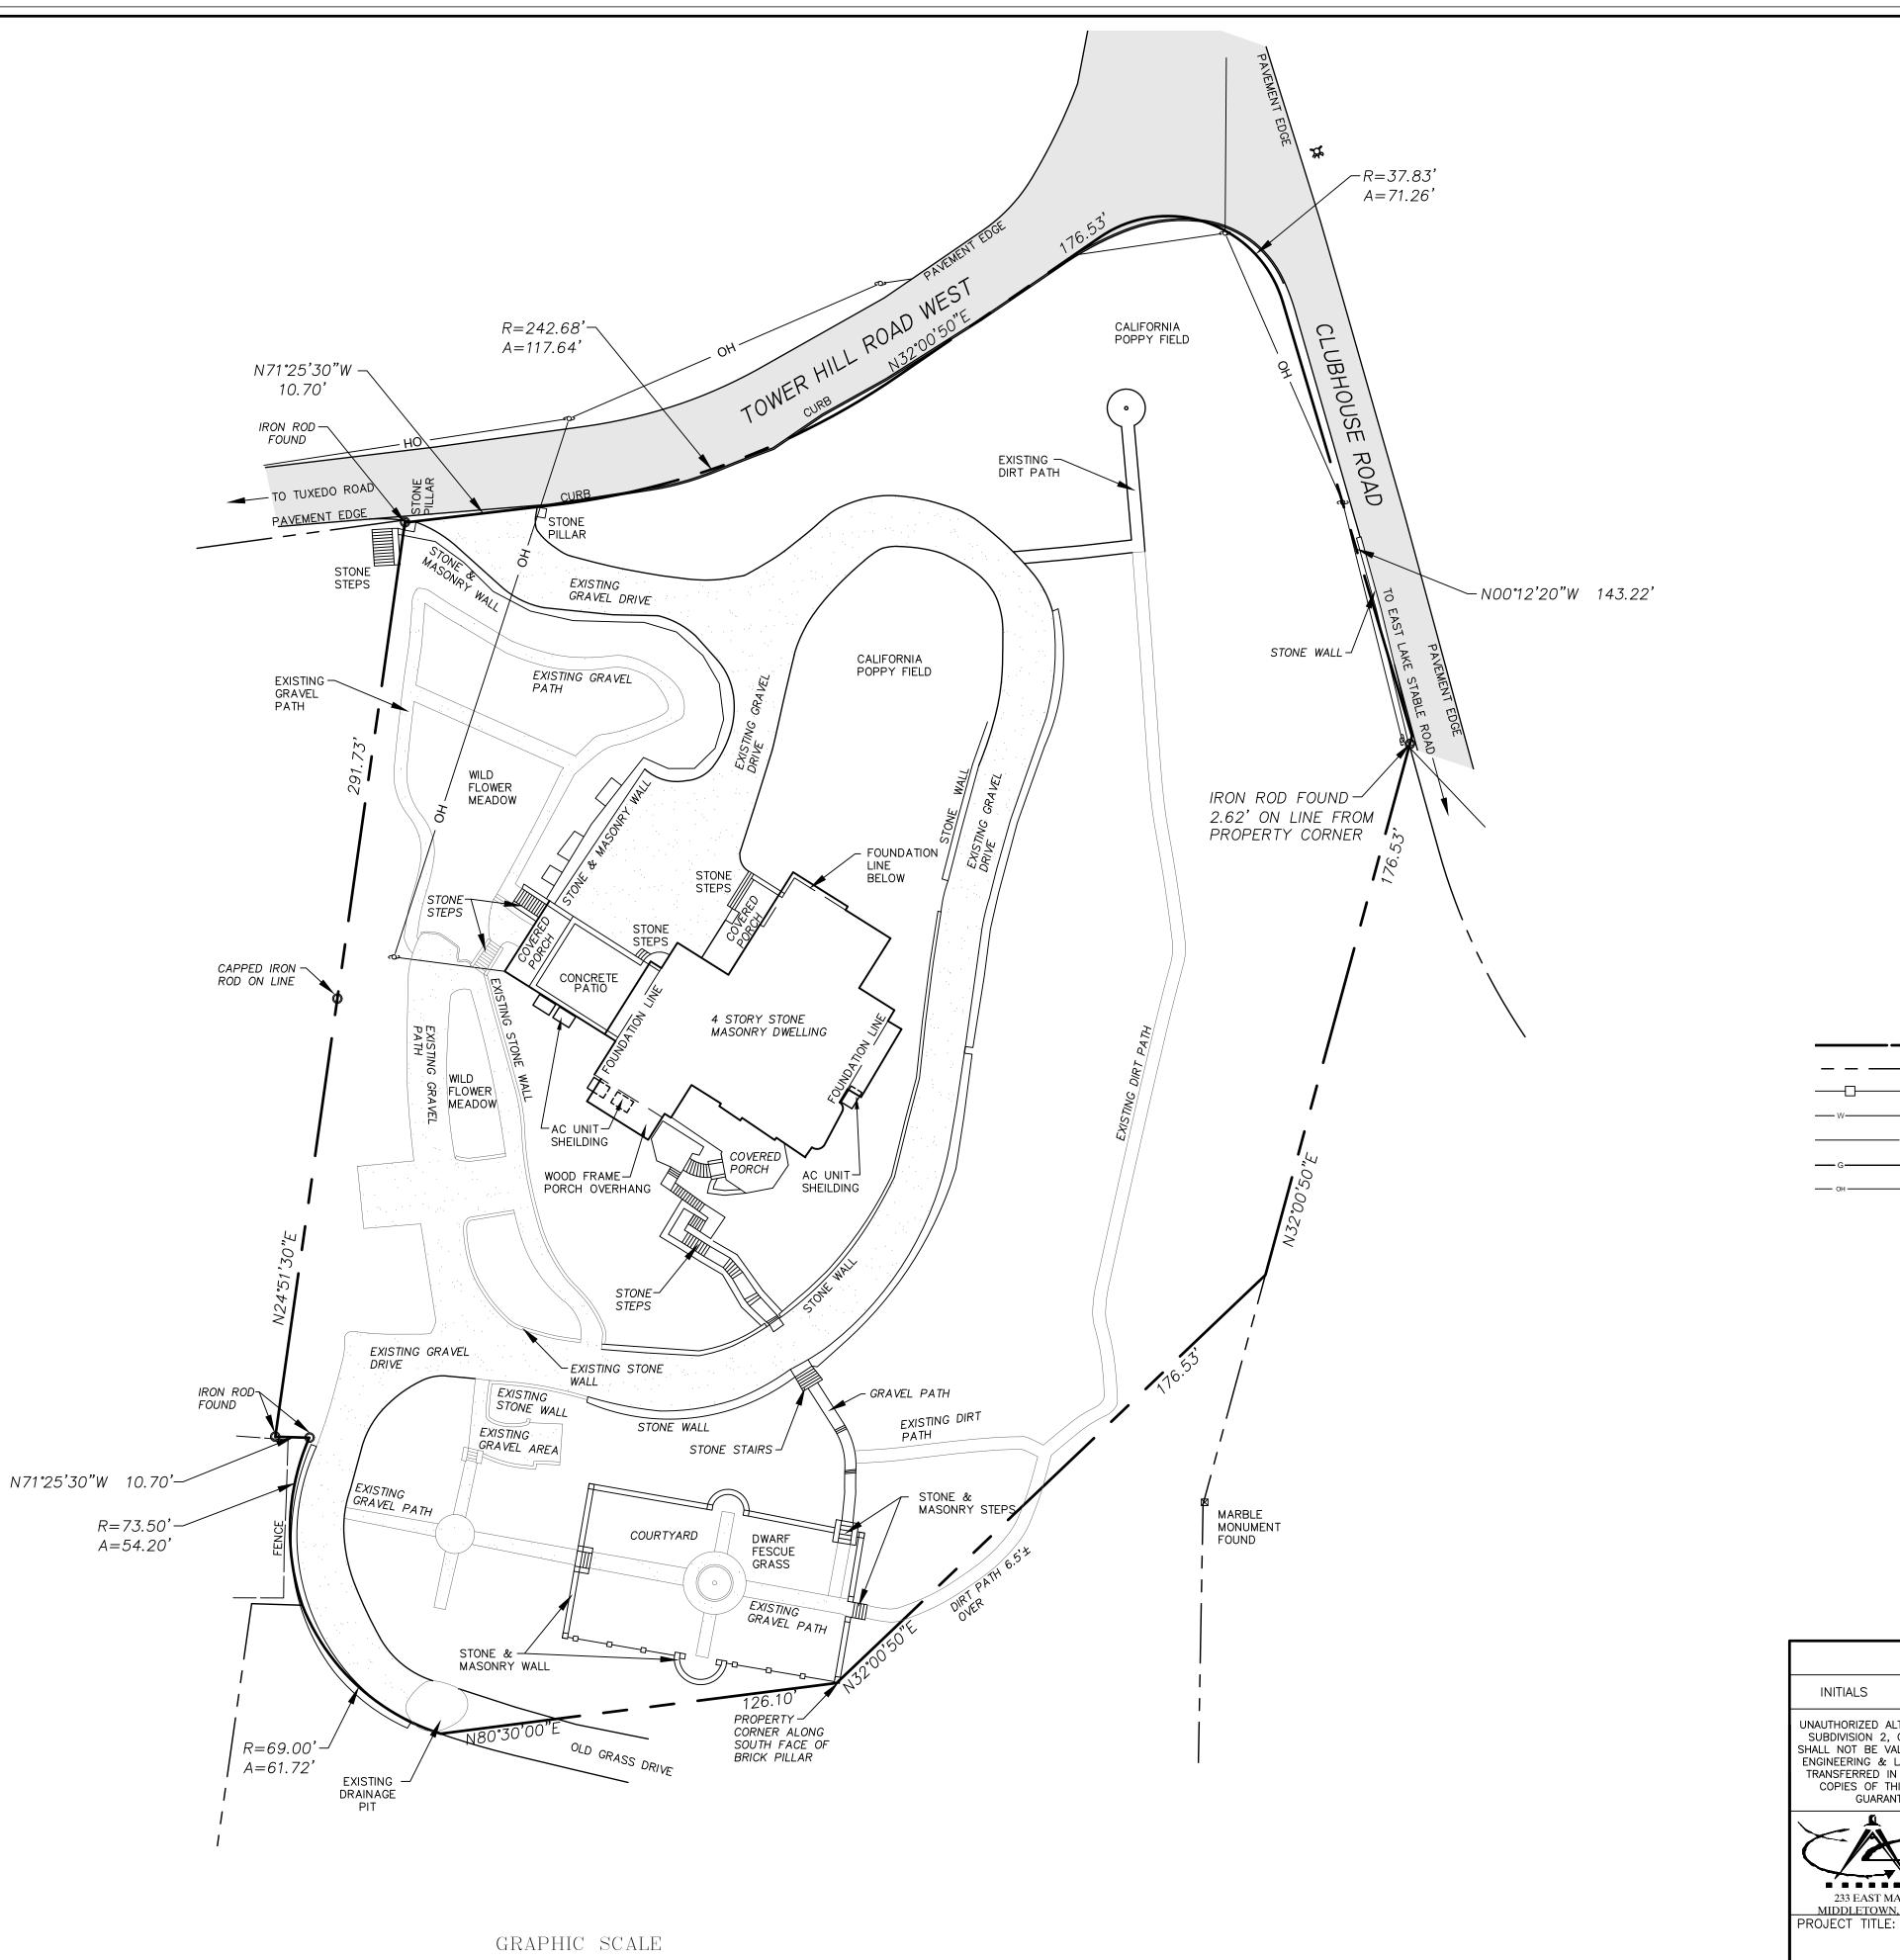TAX MAP DATA: SECTION 106 BLOCK 1 LOT 18 DEED LIBER: 15215, PAGE: 417 A SURVEY MAP ENTITLED "SURVEY PREPARED FOR LISA

HARTMAN-TING. TRUSTEE" COMPLETED BY LANC & TULLY ENGINEERING AND SURVEYING ON NOVEMBER 15, 2019.

$_LEGEND$

IRON PIPE FOUND MARBLE MONUMENT FOUND

UTILITY POLE

WATER VALVE GAS VALVE

E.M. ELECTRIC METER

 \Box G.M. GAS METER

SANITARY MANHOLE

DRAINAGE MANHOLE

WATER SHUTOFF VALVE

CATCH BASIN

HYDRANT

TREE

PROPERTY LINE — — ADJOINER PROPERTY LINE ————————— METAL FENCE — WATER LINE — SEWER LINE

— OVERHEAD UTILITIES

--- GAS LINE

INITIALS ISSUED FOR

DRAWN BY:

NM

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PREPARED FOR:

FUSCO ENGINEERING & LAND SURVEYING, D.P.C. CONSULTING ENGINEERS

PHONE: (845) 344-5863 FAX (845) 956-5865


EXISTING CONDITIONS SITE PLAN OF

PROPERTY FOR VICTORIA ALBERTA ILLAGE OF TUXEDO PARK

5/15/23

STATE OF NEW YORK COUNTY OF ORANGE REFERENCE NUMBER: APPROVED BY: ADDRESS OF PROPERTY 1"=30' EJ 22-332 116 TOWER HILL ROAD WEST SHEET NUMBER: VICTORIA ALBERTA EJ

VILLAGE OF TUXEDO PARK ORANGE COUNTY NEW YORK PAGE 1 OF 1

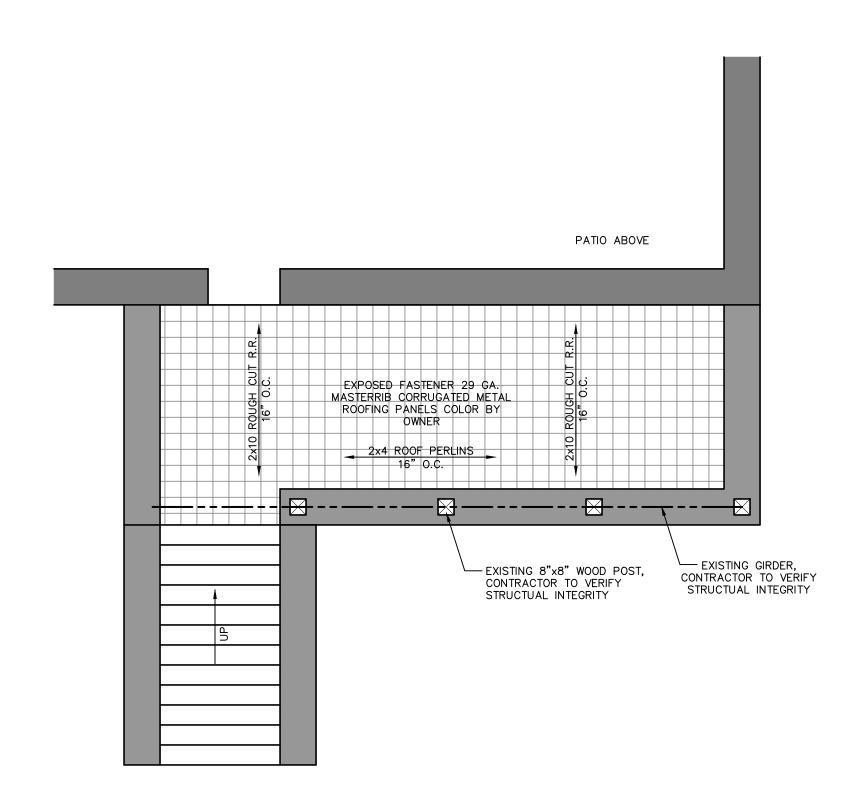

NORTHWEST COVERED PORCH PLAN

SCALE: 1/4" = 1'-0"




VIEW 'A' ENTRY TO TERRACE

SCALE: N.T.S.



VIEW 'B' FRONT ELEVATION

NOTE:
CONTRACTOR TO REUSE EXISTING MATERIAL, CONSULT THIS ENGINEER
TO DETERMINE STRUCTURE INTEGRITY. ALL RECONSTRUCTION SHALL
BE PERIOD CORRECT. CONTRACTOR TO DOCUMENT ALL WOOD
CLADDING ASSEMBLIES PRIOR TO REMOVAL

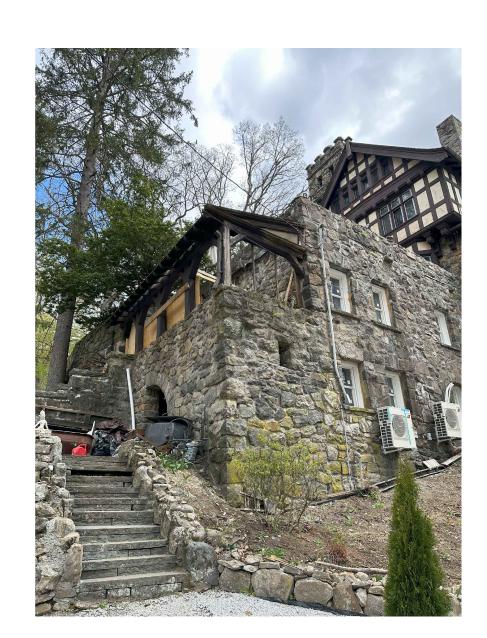

VIEW 'C' SIDE ELEVATION

GENERAL SPECIFICATIONS

NORTHWEST COVERED PORCH —

- 1. ALL WORK PERFORMED SHALL COMPLY WITH BUILDING AND ZONING ORDINANCE OF THE LOCAL AUTHORITY HAVING JURISDICTION, AND THE LATEST ADDITION OF THE IRC AND ALL APPLICABLE SUPPLEMENTAL CODES
- 2. CONTRACTOR OR ANY SUBCONTRACTOR DOING ANY WORK UNDER THIS CONTRACT SHALL CARRY LIABILITY AND PROPERTY DAMAGE INSURANCE AGAINST ACCIDENTS OF ALL KINDS AND SHALL FURNISH OWNER WITH CERTIFICATES OF INSURANCE.
- 3. CONTRACTOR SHALL BE RESPONSIBLE FOR CHECKING ALL DIMENSIONS ON THESE PLANS AGAINST FIELD CONDITION PRIOR TO CONSTRUCTION AND REPORT ANY DISCREPANCIES TO THE ENGINEER. ALL DIMENSIONS AND LOCATIONS AS—INDICATED ON THE DRAWINGS SHALL BE CONSIDERED AS REASONABLY CORRECT BUT IT SHALL BE UNDERSTOOD THAT THEY ARE SUBJECT TO MODIFICATION AS MAY BE NECESSARY OR DESIRABLE AT THE TIME OF INSTALLATION TO MEET ANY UNFORESEEN OR OTHER CONDITION.
- ALL LUMBER MATERIALS USED IN THE BUILDING SHALL BE GOOD, SOUND DRY MATERIALS FREE FROM: ROT, LARGE & LOOSE KNOTS, SHAKES AND OTHER IMPERFECTIONS WHEREBY THE STRENGTH MAY BE IMPAIRED AND OF SIZES INDICATED ON DRAWINGS. STUDS, SILLS, POSTS, LINTELS AND RAFTERS SHALL HEM-FIR (19% MAX. MOISTURE CONTENT) ALLOWING 75% NO. 1 GRADE AND 25% NO. 2 GRADE EXCEPT IF NOTED OTHERWISE HEREINAFTER IN THIS SPEC OR ON THE DRAWINGS.
- A. THE MINIMUM UNIT STRESS OF SPRUCE—PINE—FIR SHALL BE:
 GRADE: No. 1/ No. 2
 FIBER STRESS (FB) 875 PSI
 HORIZONTAL SHEAR (FV) 70 PSI
- B. THE MINIMUM UNIT STRESS OF DOUGLAS—FIR SHALL BE:
 GRADE: No. 1/ No. 2
 FIBER STRESS (FB) 825 PSI
 HORIZONTAL SHEAR (FV) 70 PSI
 MODULE OF ELASTICITY (E) 1.4 PSI
- C. THE MINIMUM UNIT STRESS OF HEM—FIR SHALL BE:
 GRADE: No. 1/ No. 2
 FIBER STRESS (FB) 1000 PSI
 HORIZONTAL SHEAR (FV) 75 PSI
 MODULE OF ELASTICITY (E) 1.6 PSI

CALCULATED DESIGN LOADS (ADD 10 PSF DEAD LOAD ALL SPANS EXCEPT ROOFS).

MODULE OF ELASTICITY (E) 1.4 PSI

ROOF 50 PSF SNOW LOAD
FLOORS 40 PSF LIVE LOAD
BEDROOMS & ATTICS 30 PSF LIVE LOAD
DECKS 50 PSF LIVE LOAD
GUARDRAILS & HANDRAILS 200 PSF HORIZONTAL POINT LOAD

"THESE PLANS AND SPECIFICATIONS ARE PREPARED IN ACCORDANCE WITH THE APPLICABLE STATE BUILDING CODES IN FORCE AT THE DATE NOTED IN THE TITLE BLOCK. IF THE CODES ARE AMENDED OR CHANGED BETWEEN THIS DATE AND THE BUILDING PERMIT DATE, THESE PLANS MUST BE REVIEWED AND REVISED AS APPLICABLE BY FUSCO ENGINEERING TO CONFORM TO THESE NEW CODES. IN ADDITION, IN NO CASE SHOULD THESE PLANS AND SPECIFICATIONS BE USED TO OBTAIN A BUILDING PERMIT MORE THAN ONE YEAR AFTER THE DATE NOTED IN THE TITLE BLOCK WITHOUT A FULL REVIEW BY FUSCO ENGINEERING AND REVISION OF THE DESIGN AS

STONE BLDG. UNDER PATIO

OVERHANG OR. STONE SILL

BM = 500.00


4 STORY STONE MASONRY DWELLING

FOUNDATION LINE -

WOOD FRAME ENCLOSED PORCH OVERHANG SUPPORTS ?

TWIN 10"-12"

SPRUCE

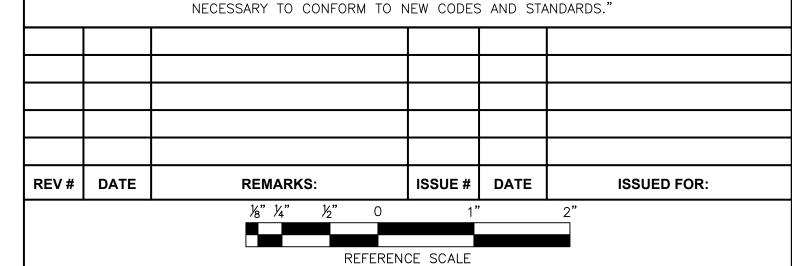

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PHONE (845) 344-5863 FAX (845) 956-5865



PROJECT TITLE:

116 TOWER HILL RD
Alberta Residence
Tuxedo Park NY

DRAWING TITLE:


NORTHWEST COVERED PORCH REPAIR

DESIGNED BY:
AFF
DATE:
6/26/23
AS SHOWN
PROJECT TITLE:


Alberta Residence
Tuxedo Park NY

APPROVED BY:
APPROVED BY:
APPROVED BY:
AFF
A-1
PAGE 1 OF 2

FREE SPACE REQUIRED AROUND OUTDOOR UNIT

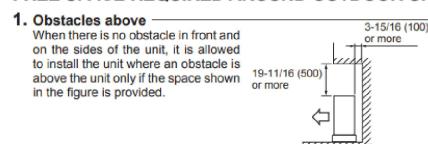



3. Obstacles in front (blowing) only When there is an obstacle in front of the unit as shown in the figure, open space above, behind, and on the sides of the unit is required.

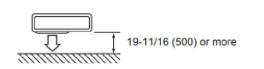


5. Obstacles in front, behind and on side(s) — · When installing the unit in an area that is enclosed with walls such as a verandah, be sure to have enough space as shown below. In this case, the air conditioning capacity and power consumption might

· When installing two or more units, do not install the units in front or behind each other.

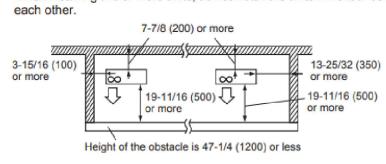


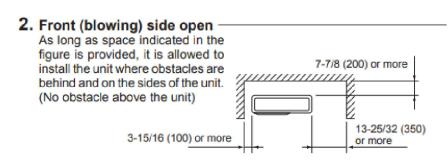



4. Obstacles in front and behind The unit can be used by attaching an optional outdoor blowing guide (MAC-856SG) (but both sides and top are open).

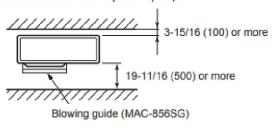


Service space — Provide space for service and maintenance as shown in the figure.

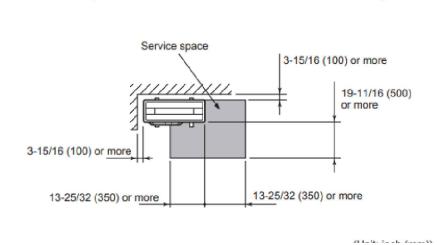

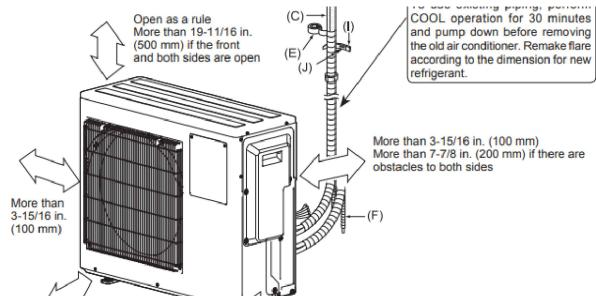

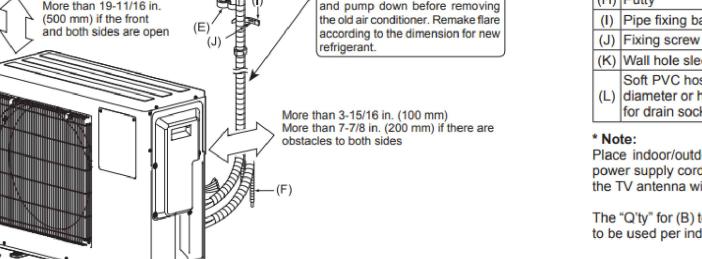

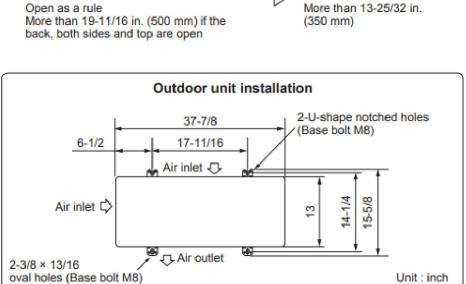


		difficult
(H)	Putty	1
(l)	Pipe fixing band	2 to 7
(J)	Fixing screw for (I)	2 to 7
(K)	Wall hole sleeve	1
(L)	Soft PVC hose, 15 mm inner diameter or hard PVC pipe VP16 for drain socket (1)	1
* Note:		

Place indoor/outdoor unit connecting wire (B) and power supply cord (A) at least 3 ft. (1 m) away from the TV antenna wire.

The "Q'ty" for (B) to (K) in the above table is quantity to be used per indoor unit.

Units should be installed by licensed contractor according to local code requirements.

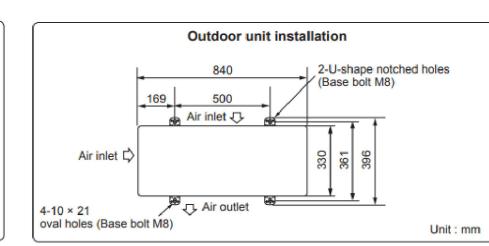





TYPICAL CONDENSER UNIT ASBUILT CONDITIONS

TYPICAL CONDENSER CLEARANCES




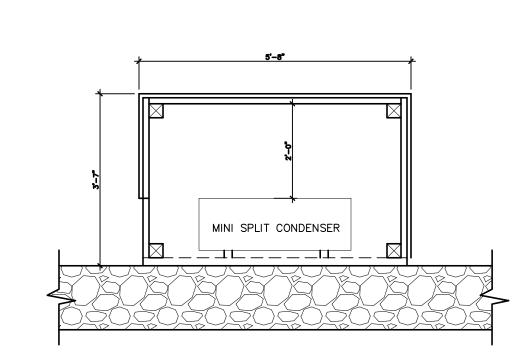

TYPICAL CONDENSER UNIT SHIELDING PLAN VIEW

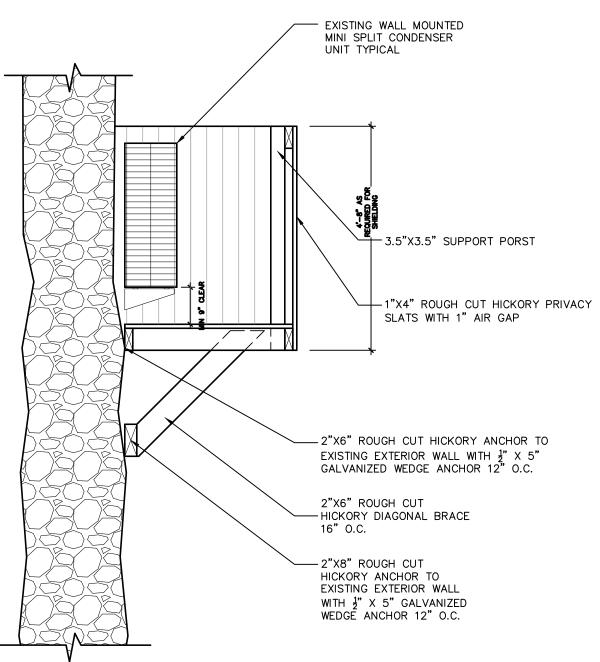

TYPCIAL CONDENSER UNIT SHIELDING ELEVATION

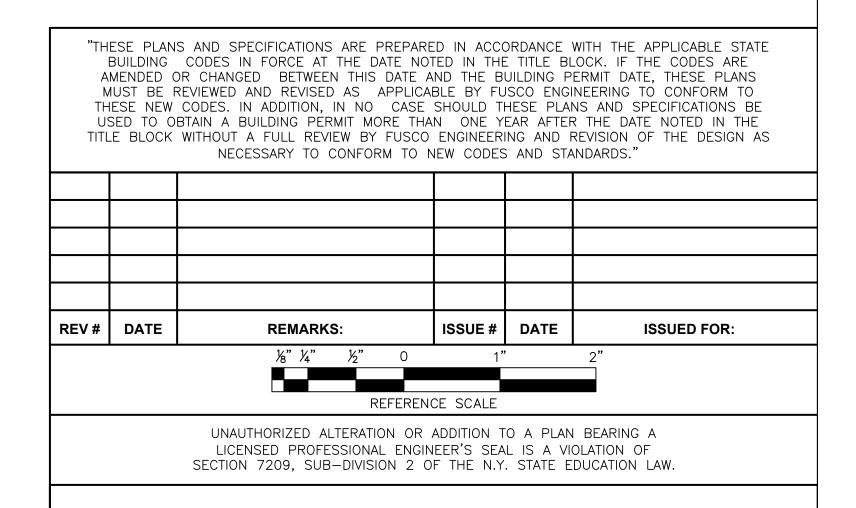



6/26/23

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22-332



116 TOWER HILL RD Alberta Residence Tuxedo Park NY WALL MOUNTED CONDENER SHIELDING PLAN AFF AFF

AS SHOWN